
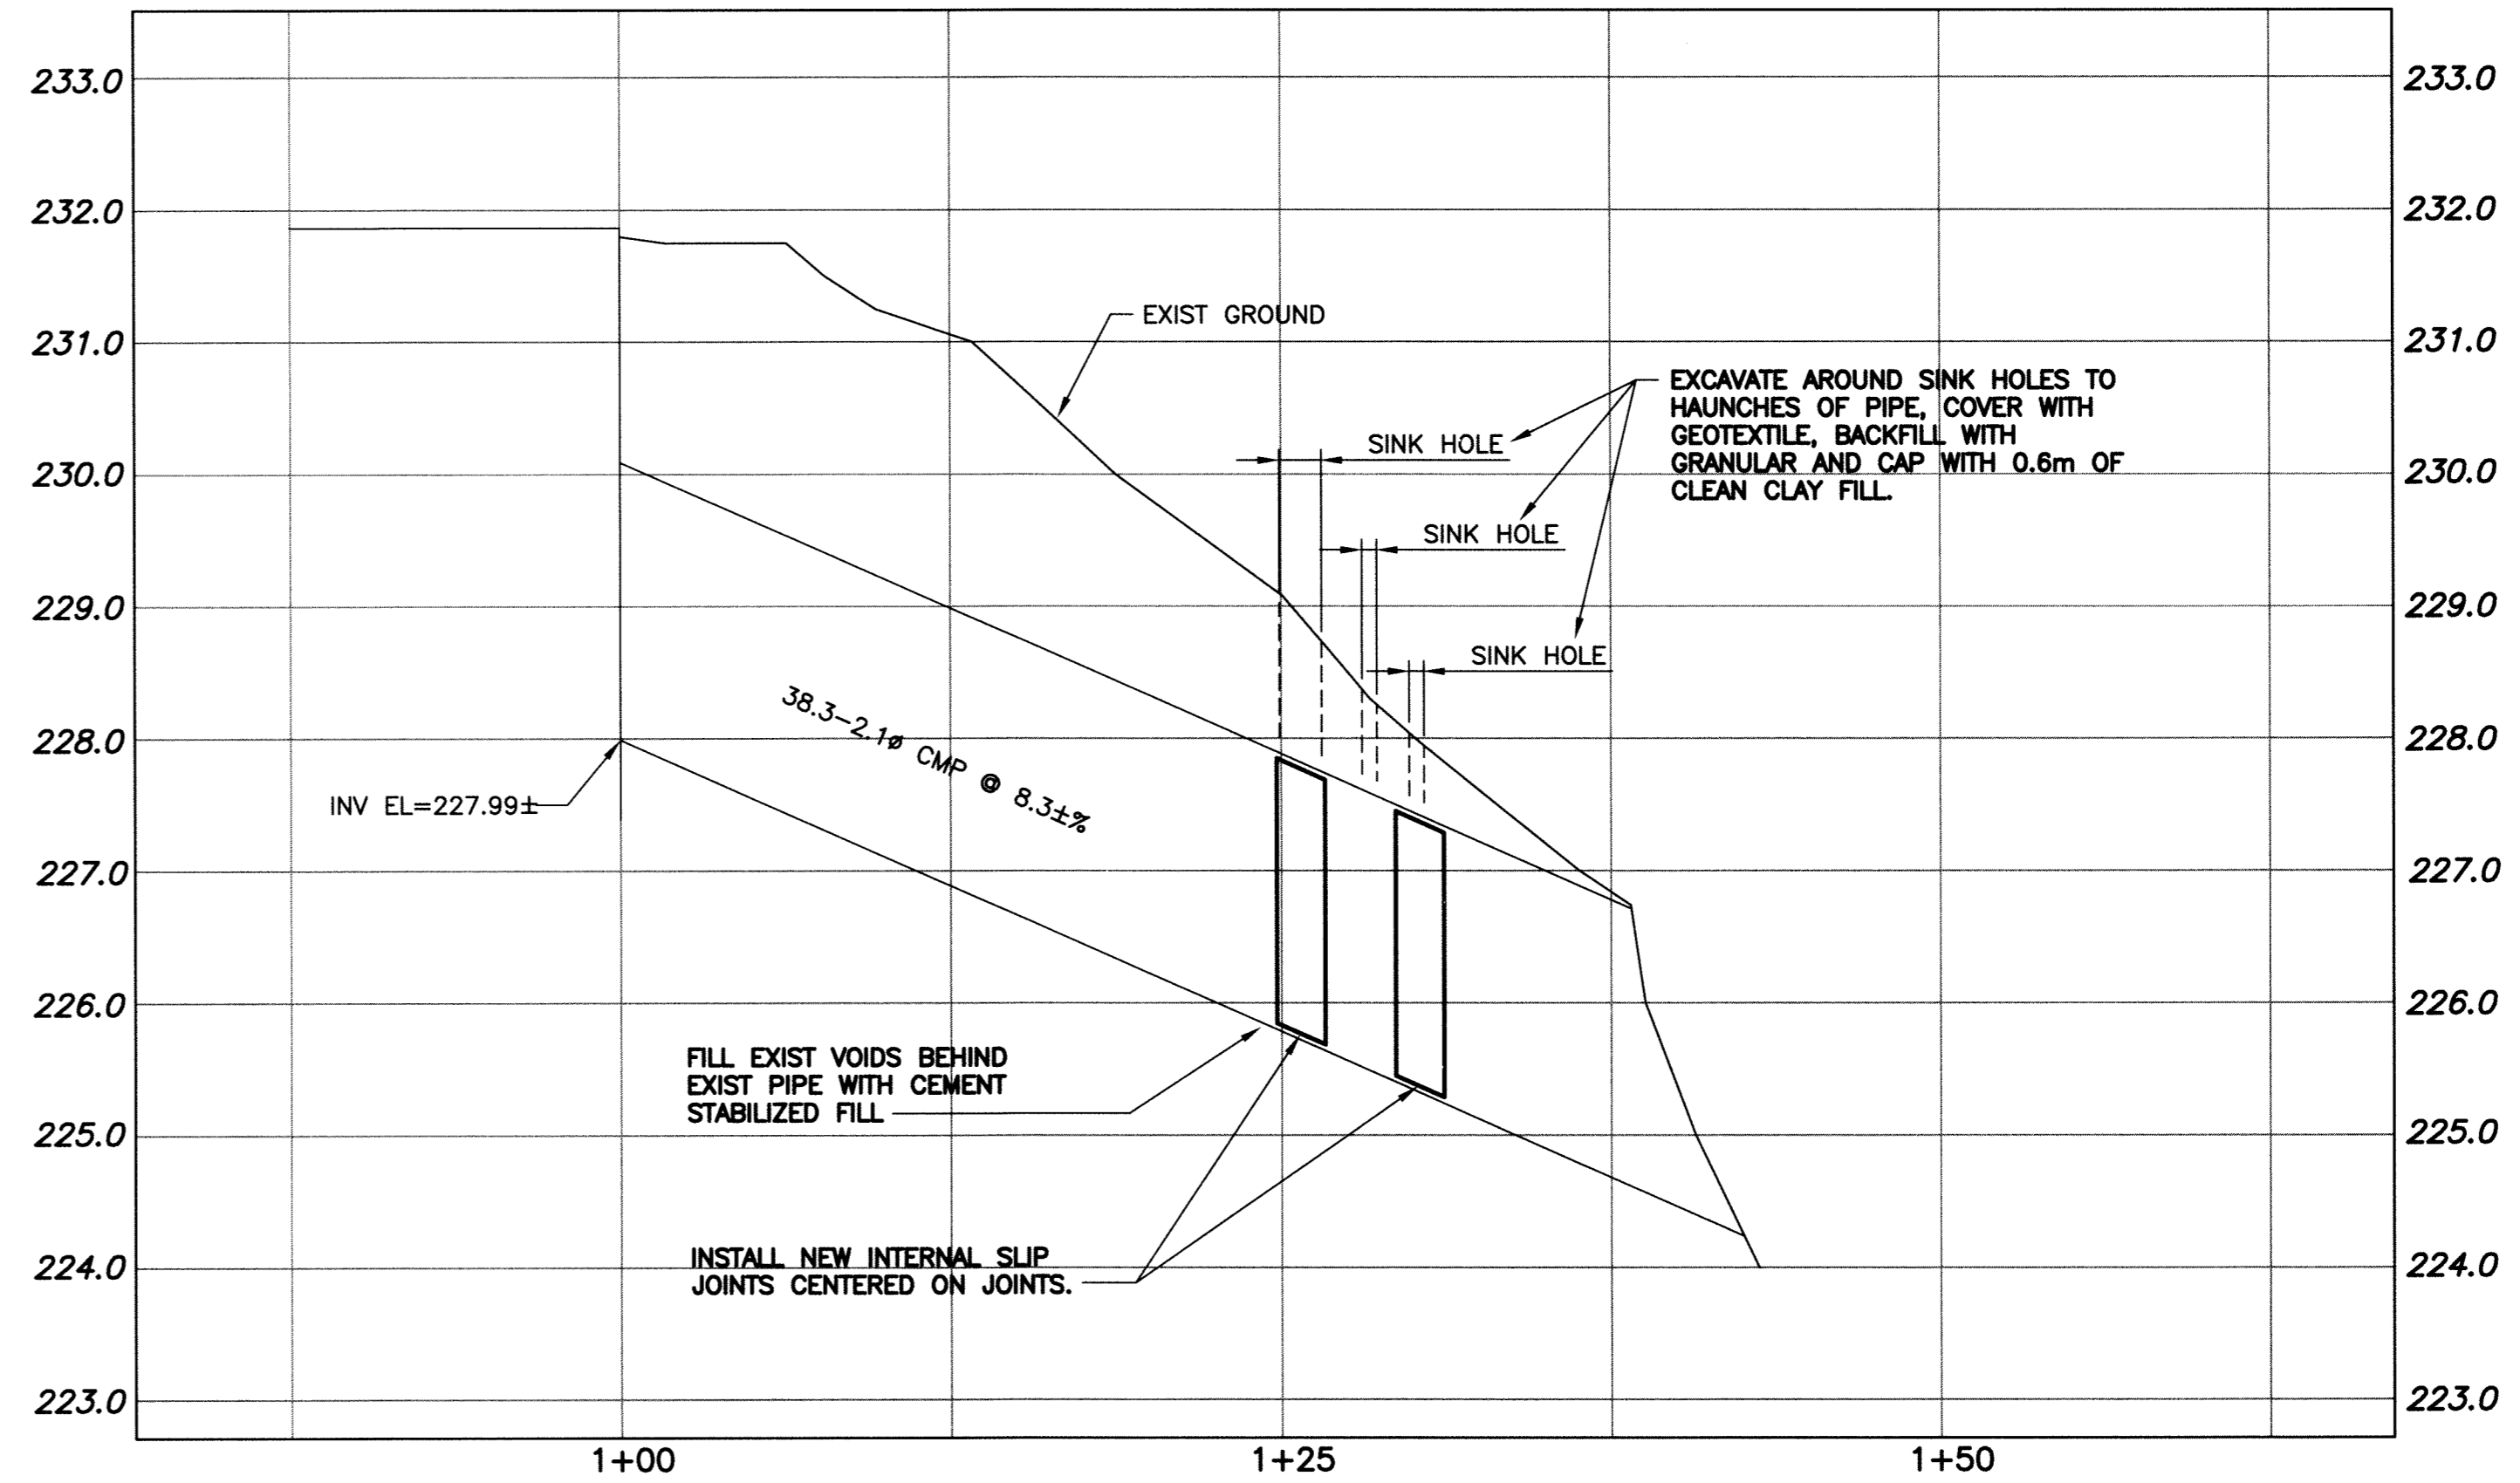


File Name: E:\Projects\2011\11-0107-33\Doc\Control\ToBeIssued\DWG\11-0107-33_LD-5727-Rev 0.dwg - Tab: LD-5727 Plotted By: DDeroche 11/12/19 [Mon 2:50pm]
 Plot Scale: 1:1

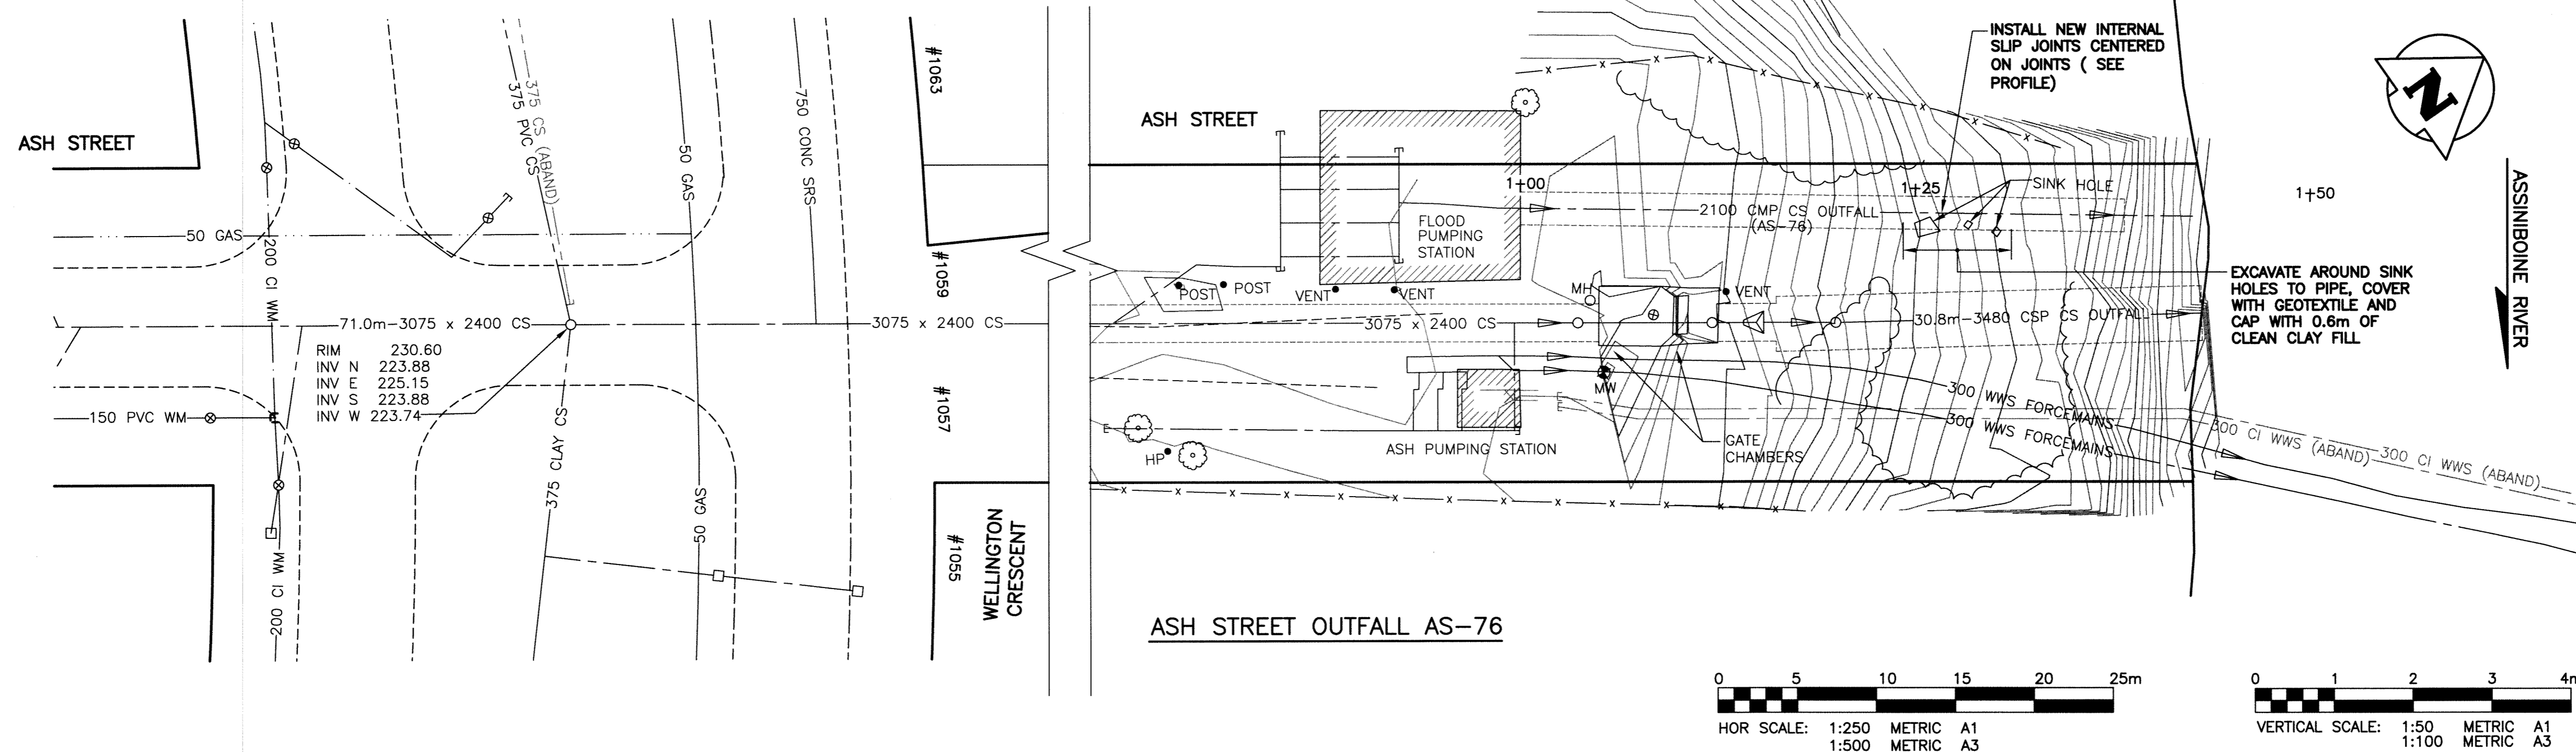


NOTE:
 1. ALL EXCAVATED MATERIAL TO BE MOVE OFF SITE

PROPERTY LIMITS DELINEATION
 DELINEATION OF PROPERTY LIMITS AS SHOWN ON THIS DWG DOES NOT REPRESENT A "LEGAL SURVEY". KGS GROUP MAKES NO REPRESENTATION OR WARRANTY AS TO THE ACCURACY OF PROPERTY LIMITS DELINEATED ON THIS DWG, NOR ON THE DIMENSIONAL ACCURACY OF DWG FEATURES RELATIVE TO THOSE PROPERTY LIMITS.

WARNING
 1. NOTIFY THE GAS COMPANY OF THE PROPOSED LOCATION OF EXCAVATION.
 2. TAKE PRECAUTION TO AVOID DAMAGE TO GAS COMPANY INSTALLATIONS.
 3. SEE PROVINCIAL REGULATION 210/72 FOR DETAILS.

METRIC
 WHOLE NUMBERS INDICATE MILLIMETRES
 DECIMALIZED NUMBERS INDICATE METRES

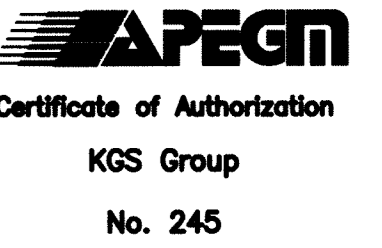


| | | | | | | | | |
|----------|---------------------|----------|--------------------|-------------|----------|----------|----------------|----------|
| 300 LBS | LAND DRAINAGE SEWER | 300 LBS | TEST HOLE | | | | | |
| 250 WWS | WASTE WATER SEWER | 250 WWS | GUY WIRE | | | | | |
| | GAS | | LIGHT STANDARD | | | | | |
| | HYDRO | | BACK OF CURB | | | | | |
| | M.T.S. | | CONCRETE | | | | | |
| 150 WM | WATERMAIN | 150 WM | ASPHALT | | | | | |
| | HYDRANT | | SIDEWALK | | | | | |
| | VALVE | | PROPERTY LINE | | | | | |
| | MANHOLE | | SURVEY BAR | | | | | |
| | CATCH BASIN | | GEODETIC BENCHMARK | | | | | |
| | CURB INLET | | ELEVATION | | | | | |
| | POLES | | | | | | | |
| EXISTING | LEGEND-PLAN | PROPOSED | EXISTING | LEGEND-PLAN | PROPOSED | EXISTING | LEGEND-PROFILE | PROPOSED |

LOCATION APPROVED UNDERGROUND STRUCTURES
 SUPV. U/G STRUCTURES COMMITTEE DATE
 NOTE:
 LOCATION OF UNDERGROUND STRUCTURES AS SHOWN ARE BASED ON THE BEST INFORMATION AVAILABLE BUT NO GUARANTEE IS GIVEN THAT ALL EXISTING UTILITIES ARE SHOWN OR THAT THE GIVEN LOCATIONS ARE EXACT. CONFIRMATION OF EXISTENCE AND EXACT LOCATION OF ALL SERVICES MUST BE OBTAINED FROM THE INDIVIDUAL UTILITIES BEFORE PROCEEDING WITH CONSTRUCTION.

| | |
|-----------------------|--|
| B.M. KGS BASE ELEV. - | DWGS BASED ON C.S.R.S. NAD 83 SYSTEM, UTM GRID |
| ISSUED FOR TENDER | 11/12/19 |
| NO. REVISIONS | DATE BY |

| | |
|---------------------------------------|----------------------------|
| KGS GROUP CONSULTING ENGINEERS | |
| DESIGNED BY: RBO | CHECKED BY: RJH |
| DRAWN BY: DMW | APPROVED BY: |
| HOR. SCALE: 1:250 | RELEASED FOR CONSTRUCTION: |
| VERTICAL: 1:50 | DATE |
| DATE: 11/11/03 | DATE: |

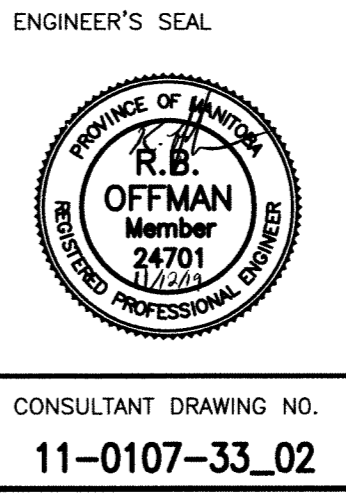

THE CITY OF WINNIPEG
 WATER AND WASTE DEPARTMENT

PROJECT TITLE:
2012 OUTFALL RENEWAL/REHABILITATION PROGRAM
ASH STREET OUTFALL (AS-76) PROPOSED PLAN AND PROFILE

SHEET OF
02 07
 COMPUTER FILE NAME
11-0107-33_02
 CITY DRAWING NUMBER
LD-5727

CONSULTANT DRAWING NO.
11-0107-33_02